Si necesita ayuda para comprender esta informacion, por favor llame 503-588-6173

DECISION OF THE HISTORIC LANDMARKS COMMISSION

HISTORIC DESIGN REVIEW CASE NO.: HIS19-23

APPLICATION NO.: 19-113171-DR

NOTICE OF DECISION DATE: JULY 19, 2019

SUMMARY: A proposal to install HVAC, a new canopy, and additional improvements on the front facade of the Pomeroy & Keene Building (c1860).

REQUEST: Major Historic Design Review of a proposal to install new HVAC on the roof, remove the existing awning and install a new metal canopy, restore the original wood storefront, replace the glass within the original transom window openings, and add new signage and lighting on the exterior of the Pomeroy & Keene Building (c1860), a historic contributing resource within the Salem Downtown National Register Historic District located at 379-383 State Street (Marion County Tax Assessors Number 073W27AB06400).

APPLICANT: Gary Gunville and Marie Jacobsen, AC+Co Architecture, on behalf of Janet I. Ogdahl

LOCATION: 379-383 State Street / 97301

CRITERIA: Salem Revised Code (SRC) Chapters 230.040 (d) and (j)

FINDINGS: The findings are in the attached Decision dated July 18, 2019.

DECISION: The **Historic Landmarks Commission APPROVED** Historic Design Review Case No. HIS19-23 subject to the following condition of approval:

Condition 1. The applicant shall salvage the 1926 transom window glass after removal, using accepted preservation and storage methods. The 1926 transom glass shall be retained in a secure storage area on-site, so future restoration of this glazing from the 1926 storefront remodel is potentially feasible.

VOTE:

Yes 5 No 2 (Schwartz, Zimmerman) Absent 2 (French, Schutte)

Jennifer Maglinte-Timbrook, Chair Historic Landmarks Commission HIS19-23 Decision July 19, 2019 Page 2

This Decision becomes effective on <u>August 6, 2019</u>. No work associated with this Decision shall start prior to this date unless expressly authorized by a separate permit, land use decision, or provision of the Salem Revised Code (SRC).

The rights granted by the attached decision must be exercised, or an extension granted, by August 6, 2021 or this approval shall be null and void.

Application Deemed Complete:

June 21, 2019

Public Hearing Date:

July 18, 2019

Notice of Decision Mailing Date:

July 19, 2019

Decision Effective Date:

August 6, 2019

State Mandate Date:

October 19, 2019

Case Manager: Kimberli Fitzgerald, kfitzgerald@cityofsalem.net, 503-540-2397

This decision is final unless written appeal from an aggrieved party is filed with the City of Salem Planning Division, Room 305, 555 Liberty Street SE, Salem OR 97301, no later than 5:00 p.m., Monday, August 5, 2019. Any person who presented evidence or testimony at the hearing may appeal the decision. The notice of appeal must contain the information required by SRC 300.1020 and must state where the decision failed to conform to the provisions of the applicable code section, SRC Chapter 230. The appeal must be filed in duplicate with the City of Salem Planning Division. The appeal fee must be paid at the time of filing. If the appeal is untimely and/or lacks the proper fee, the appeal will be rejected. The Hearings Officer will review the appeal at a public hearing. After the hearing, the Hearings Officer may amend, rescind, or affirm the action, or refer the matter to staff for additional information.

The complete case file, including findings, conclusions and conditions of approval, if any, is available for review at the Planning Division office, Room 305, City Hall, 555 Liberty Street SE, during regular business hours.

http://www.cityofsalem.net/planning

Si necesita ayuda para comprender esta informacion, por favor llame 503-588-6173

DECISION OF THE SALEM HISTORIC LANDMARKS COMMISSION

CASE NO. Historic Review Case No. HIS19-23

FINDINGS: Based upon the application materials, the facts and findings in the Staff Report incorporated herein by reference, and testimony provided at the Public Hearing of July 18, 2019, the Historic Landmarks Commission (HLC) finds that the applicant adequately demonstrated that their proposal complies with the applicable provisions of the Salem Revised Code (SRC) 230.040 as follows:

Criteria: 230.040(d) Storefronts and 230.040(j) Mechanical equipment and service areas.

FINDINGS

230.040(d) Storefronts. Replacement of storefronts or components of storefronts in historic contributing buildings shall be allowed only where the owner has attempted repair, but repair was determined to be unfeasible due to poor condition of the materials. If the storefront is not original then every effort shall be made to replicate the original feature; the effort shall be substantiated by historic, physical, or pictorial evidence. If the feature cannot be replicated then it should be of a compatible design and material.

- (1) Materials.
- (A) Original material shall, if possible, be retained or repaired.

Finding: The HLC finds that the applicant is proposing to restore the original character defining features of the storefront, therefore staff recommends that the HLC find that SRC 230.040(d)(1)(A) has been met for this portion of the proposal. Additionally, the applicant is proposing to replace the glass within the existing transom window openings. While the transom windows are not original to the structure, they were added as part of the 1926 remodel. While not original to the structure, this glazing was added during the historic period for the Downtown Historic District and is unique to this structure. Therefore, while the HLC finds that replacement with clear glass is acceptable, the HLC adopts the following **CONDITION** to better meet this standard:

- **CONDITION 1:** The applicant shall salvage the 1926 transom window glass after removal, using accepted preservation and storage methods. The 1926 transom glass shall be retained in a secure storage area on-site, so future restoration of this glazing from the 1926 storefront remodel is potentially feasible.
- (B) Replacement materials shall be, to the greatest extent practicable, of the same type, quality, design, size, finish, proportions, and configuration of the original materials in the storefront.

Finding: The HLC finds that the applicant is proposing to repair and retain the transom window openings and install clear glass single panes within the existing frames, retaining their original

HIS19-23 July 18, 2019 Page 2

configuration and that SRC 230.040(d)(1)(B) has been met for this portion of the proposal. Additionally, the HLC finds that the applicant is proposing to replace the non-original fabric awning with a steel metal canopy that will include metal gutters, signage and lighting. The replacement materials are primarily of metal, which is a traditional material found on the Pomeroy & Keene Building and similar historic contributing buildings throughout the Downtown Historic District, therefore the HLC finds that this standard has been met for this portion of the proposal.

(2) Design.

(A) To the extent practicable, original storefront components such as windows, door configuration, transoms, signage, and decorative features shall be preserved.

Finding: The HLC finds that the applicant is planning to substantially retain and restore the character defining features of the Pomeroy & Keene Building 1926 storefront, therefore SRC230.040(d)(2)(A) has been met for this portion of the proposal. Additionally, the HLC finds that the applicant is proposing to replace the non-original fabric awning with a steel metal canopy that will include gutters, signage and lighting. No original or character defining features from the 1926 storefront will be adversely affected by the installation of the awning and associated components, therefore the HLC finds that this standard has been met for this portion of the proposal.

- (B) Where the original storefront is too deteriorated to save, the commercial character of the building shall be retained through:
- (i) A restoration of the storefront based on historical research and physical evidence.

Finding: The HLC finds that the applicant is proposing restoration of the 1926 Pomeroy & Keene Building storefront, therefore SRC 230.040(2)(B)(i) has been met.

(ii) Contemporary design that is compatible with the scale, design, materials, color and texture of historic compatible buildings in the district.

Finding: The HLC finds that the applicant is not proposing a replacement storefront, therefore this criterion is not applicable to the evaluation of this portion of the proposal. However, the HLC finds that the applicant is proposing to replace the existing non-original fabric awning with a flat topped metal canopy that will include gutters, signage and lighting. The overall design of this replacement canopy and associated components are compatible with the Pomeroy & Keene Building and the surrounding Downtown Historic District, therefore the HLC finds that SRC 230.040(d)(2)(B)(ii) has been met for this portion of the proposal.

(C) For buildings that provide a separate upper-story entrance on the exterior façade, the street-level entrance should be the primary focus of the building façade.

Finding: The HLC finds that the applicant is proposing to replace the non-original gate and screen door with a metal gate over the entry to the upper floor. However, the 1926 street-level

HIS19-23 July 18, 2019 Page 3

entrances to the two retail spaces within the Pomeroy & Keene Building will be retained. Therefore the HLC finds that SRC 230.040(d)(2)(C) has been met.

230.040(j) Mechanical equipment and service areas.

(1) Materials. Materials shall be harmonious in type, color, scale, texture, and proportions with the building and the district generally.

Finding: The HLC finds that the proposed replacement HVAC unit will be of metal, a traditional material found on the Pomeroy & Keene Building, and the district generally, therefore the HLC finds that SRC 230.040(j)(1) has been met.

- (2) Design.
- (A) Mechanical equipment and service areas should be located out of public view and designed as an integral part of the overall building design.

Finding: The HLC finds that the applicant is proposing to replace the existing HVAC unit with a new unit located at the center of the roof and not visible from the right of way and that SRC 230.040(j)(2)(A) has been met.

(B) Mechanical equipment and service areas should be placed at the rear of the building, recessed on the roof of the building, or screened by appropriate fencing.

Finding: The HLC finds that the applicant is proposing to replace the existing HVAC unit with a new unit recessed at the center of the roof of the building and not visible from the right of way. Therefore the HLC finds that SRC 230.040(j)(2)(B) has been met.

(C) Low-profile mechanical units and elevator shafts may be placed on rooftops if they are not visible from the street, or set back and screened from view.

Finding: The HLC finds that the proposed mechanical unit will be set back from the parapet of the roof, not visible from the street and recessed at the center of the roof, therefore the HLC finds that SRC 230.040(j)(2)(C) has been met.

(D) Solar panels should have low profiles and not be visible from right-of-way, other than alleys, and shall be installed in a manner that minimizes damage to historic materials.

Finding: The HLC finds that the applicant is not proposing to install solar panels, therefore this criterion is not applicable to the evaluation of this proposal.

(E) Skylights shall be flat and shall not alter the existing profile of the roof. Bubble-type skylights are prohibited.

HIS19-23 July 18, 2019 Page 4

Finding: The HLC finds that the applicant is not proposing to install skylights, therefore this criterion is not applicable to the evaluation of this proposal.

(F) Mechanical equipment placed at street level should be screened in a manner that is compatible with the streetscape and adjacent buildings.

Finding: The HLC finds that the applicant is not proposing to install mechanical equipment at street level, therefore this criterion is not applicable to the evaluation of this proposal.

(G) New skylights and vents shall be placed behind and below the parapet level.

Finding: The HLC finds that the applicant is not proposing to install new skylights or vents, therefore this criterion is not applicable to the evaluation of this proposal.

DECISION: The Historic Landmarks Commission **APPROVES THE PROPOSAL** with the following **CONDITION:**

CONDITION 1: The applicant shall salvage the 1926 transom window glass after removal, using accepted preservation and storage methods. The 1926 transom glass shall be retained in a secure storage area on-site, so future restoration of this glazing from the 1926 storefront remodel is potentially feasible.

VOTE: Yes 5 No 2 (Schwartz, Zimmerman) Absent 2 (French, Schutte) Abstain 0

Attachments: A. Vicinity Map


B. Excerpt from National Register Historic Resource Document

C. Applicant's Submittal Materials

Prepared by Kimberli Fitzgerald, Historic Preservation Officer

\\allcity\CDGroup\CD\PLANNING\HISTORIC\DECISIONS\2019\HIS19-23 379 State Street. Dec.doc

Vicinity Map 379-383 State St

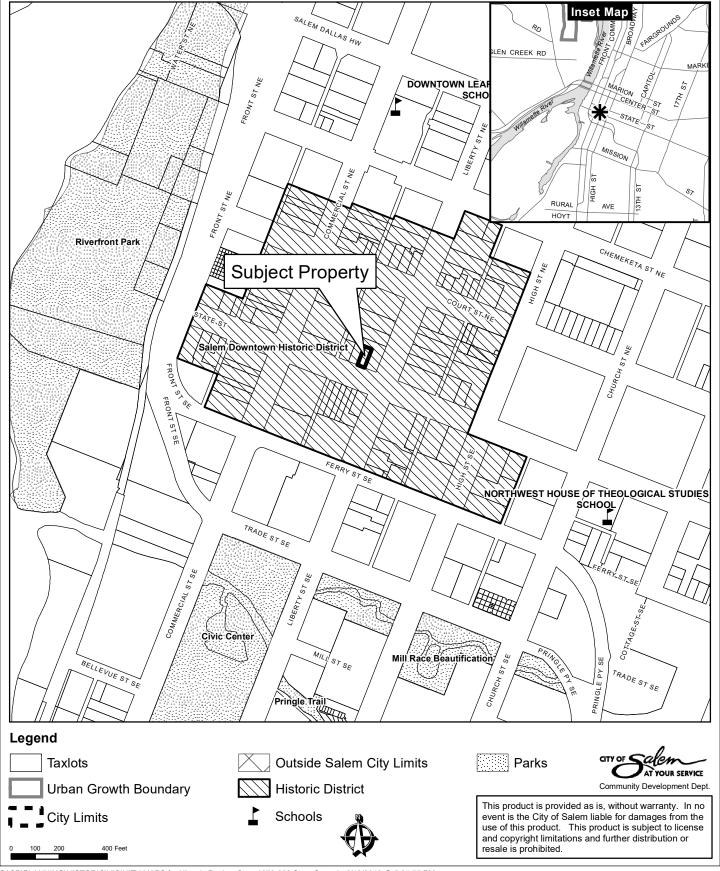

Excerpt from National Register Documentation

379 - 383 State Street

Classification: Historic Contributing (Listed as a Local Landmark)

Historic Name: Pomeroy Building Current Name: MaValise/Coiffeure Year of Construction: c. 1860/1926

Legal Description: 073W27AB06400; Salem Addition from Lot 4 in Block 33

Owner(s): Charles Zawell

POB 2248

Salem, Oregon 97308

<u>Description</u>: This is a two-story unreinforced brick building covered with stucco, scored to simulate stone. The primary facade (south-facing) has three medallions equally spaced across the facade. The second-story fenestration is comprised of two window bays, each with two one-over-one, double-hung wood sash windows. Each window bay is surmounted with a bas-relief arch that continues into bay surrounds. Within each bay is a pilaster with rope ornamentation that separates the two windows.

Multiple arched transom windows provide illumination for ground-floor spaces. The ground floor is divided into two equal shop spaces, each with a central recessed door. Display windows trimmed in marble and ornate woodwork date from a 1926 remodeling. This building retains its historic integrity and contributes to the downtown district.

<u>History and Significance</u>: The Pomeroy Building contributes to an understanding and appreciation of the evolving history of commercial developments in the downtown historic district. It has retained substantial architectural integrity since its 1926 remodel and is associated with the lives of several tenants who contributed to legal developments in the capital city. When originally built around 1860 (according to the Oregon Inventory of Historic Properties, 1993), this building served as a rooming house. In 1925 Charles T. Pomeroy (a jeweler) and A.A. Keene purchased this property. A Portland carpenter and cabinetmaker remodeled the facade in accordance with plans prepared by Pomeroy and Keene, transforming the architectural style into Commercial. As of June 1993, Pomeroy's daughter, Audrey, was managing the jewelry store.

Earlier tenants in the building included Miller Hayden of the Real Silk Hosiery Company (he later became a lawyer and state district judge); Fred Binyon, insurance agent and notary public (later to serve as an assistant attorney general attached to the Oregon State Insurance Department for seventeen years); and attorney C.F. Gillette (also city attorney for Monmouth, Oregon).

Kadas, "Oregon Inventory of Historic Properties," June, 1993.


HIS19-23 Additional Research



REFERENCE ONLY 1934 View of Pomeroy and Keene Building

Postcard, "No. 69, State Street Looking Towards Capitol, Salem, Oregon"
Held at Willamette University Archive
WP 0840, Box 7
https://doi.org/10.31096/WUA9999-WP_0840_Box_7



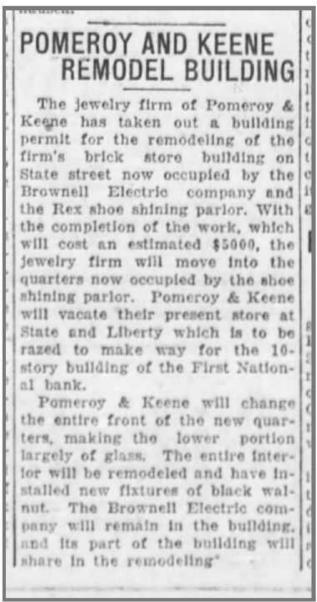

Capital Journal, April 14, 1926, p. 1



1941 detail from State St. View, Ben Maxwell Collection, 1374

Historic Alteration Review Worksheet

Site Address: 379 - 383 STATE ST.				
Resource Status: Contributing Non- Contributing Individual Landmark				
Type of Work Activity Proposed:	Major Minor □			
Chose One: Commercial District Residential District		Public District		
Replacement, Alteration, Restoration or Addition of				
Architectural Feature:	Landscape Feature:	New:		
☑ Awning	□ Fence	□ Addition		
□ Door	□ Streetscape	□ Accessory Structure		
□ Exterior Trim, Lintel	□ Other Site feature (describe)	□ Sign		
□ Other architectural feature		□ Mural		
□ Roof/Cornice		□ Accessibility Ramp		
□ Masonry/Siding		□ Energy Improvements		
□ Storefront		□ Mechanical Equipment		
Window(s) Number of windows:	·	□ Primary Structure		
	9			
Will the proposed alteration be visible from <u>any</u> public right-of-way? ■ Yes □ No				
Project's Existing Material: Project's New Material: METAL CANOPY				
Project Description				
Briefly provide an overview of the type of work proposed. Describe how it meets the applicable design criteria in SRC Chapter 230. Please attach any additional information (i.e., product specification sheets) that will help staff and the HLC clearly understand the proposed work:				
1. DEPLACE EXISTING METAL CANOPY WITH NEW METAL CANOPY.				
2. REPLACE GLASS IN EXISTING TRANSOM WINDOWS WITH CLEAR TEMPERED GLASS.				
3. ADD (3) BLADE SIGNS AND (3) SIGNS ON FACE OF CANOPY.				
4. ADD LIGHT FIXTURES AT UNDERSIDE OF CANOPY, TO BE DIRECTED AT BLADE				
SIGNS.				
Car Car 1		1 1 1		
(Sun Suns		0-1-19		
Signature of Applicant		Date Submitted/Signed		

City of Salem Permit Application Center - 555 Liberty Street SE / Room 320 - Salem, OR 97301 / (503) 588-6213

June 6, 2019

City of Salem Planning Dept. 555 Liberty Street SE Salem, OR 97301

Re: 379-383 State Street - Historic Review

The following addresses the applicable approval criteria per Section 230.040 of Title X Unified Development Code;



Sec. 230.040. - Standards for historic contributing buildings in commercial historic districts. Modification to historic contributing buildings in public historic districts and individually listed public historic resources shall comply with this section.

(b) Windows. Replacement of windows and individually listed public historic resources shall be allowed only where the owner has attempted to repair the original window, but repair was not feasible due to the poor condition of the original materials. If the window is not original then every effort shall be made to replicate the original window; the effort shall be substantiated by historic, physical, or pictorial evidence. If the window cannot be replicated then it should be of a compatible design and material.


Response: The owner would like to change out the glass in each of the transom windows. The glass would be clear, single pane to fit the existing wood frames and be tempered because of the distance to the existing mezzanine floor. The existing window frames will remain and are to be repaired and painted.

(k) Awnings and canopies. Replacement or installation of awnings and canopies on historic contributing buildings is allowed. (1) Materials. (A) Materials that are compatible with the character of the building's period and style shall be used. (B) Canvass is an approved material for awnings and canopies. (2) Design. (A) Awnings shall be located within window openings, and below transoms. (B) Umbrella-type awnings and non-historic forms are not permitted. (C) Awnings shall be attached in such a manner that historic materials or features are not damaged. (D) Marquees may be used where compatible with the building and neighboring buildings. (E) Awnings, canopies, or marquees shall not obscure significant architectural features on the building. (F) Awnings, canopies, or marquees shall have size, scale and design that is compatible with the building and neighboring buildings.

Response: The owner would like to replace the existing metal and fabric canopy with a new metal only canopy. The canopy would be 5 feet deep to align with the canopies of the neighboring buildings on each side. The canopy would have a metal gutter along the backside with a new metal downspout in the location of the existing downspout. (3) Blades would hang from the canopy and align with the business entries at 379, 381 and 383 State Street. (3) smaller signs would be attached to the front face of the canopy frame.

End of Statement.

SITE - PHOTOS

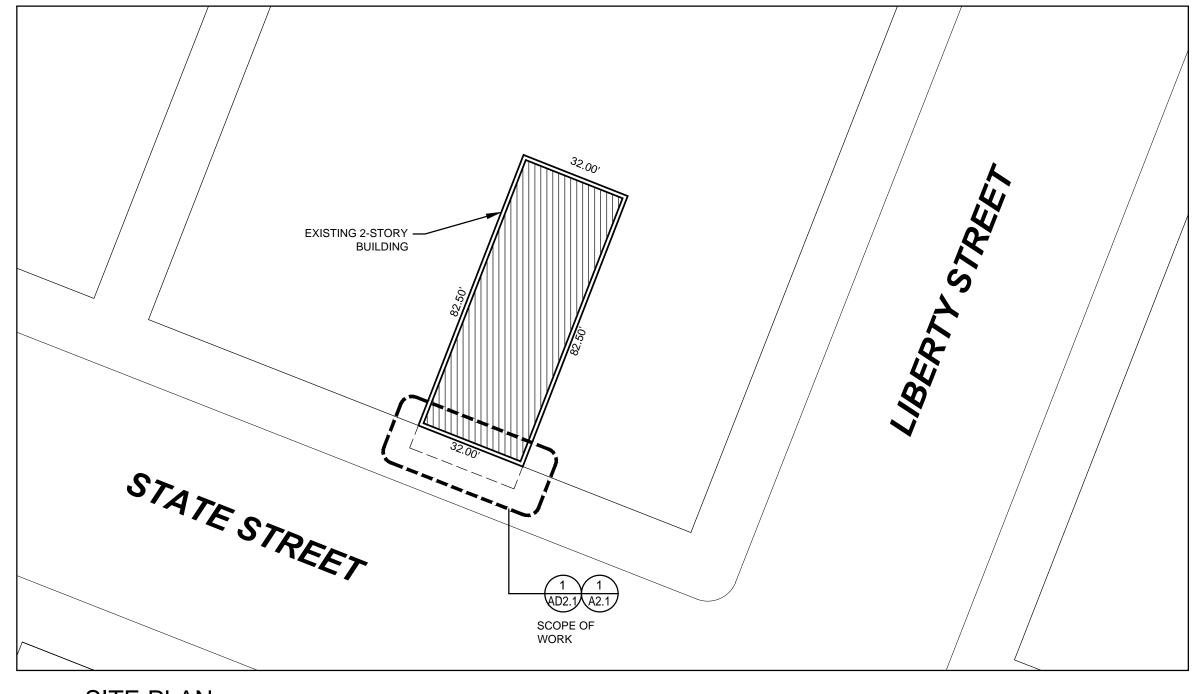



BUILDING EXTERIOR - 1980's









BUILDING EXTERIOR - 1941

CONSTRUCTED IN 1860, THE 2-STORY BRICK COMMERCIAL BUILDING WAS ORIGINALLY USED AS A ROOMING HOUSE. PURCHASED IN 1925 BY CHARLES T. POMEROY AND A.A. KEENE WITH THE GROUND LEVEL SPACES BEING USED AS A JEWELRY STORE AND AN OPTOMETRIST'S OFFICE. IN 1926 THE BUILDING WAS REMODELED IN THE ART NOUVEAU STYLE, WHICH WAS POPULAR IN THE 1920'S. KNOWN AS THE POMEROY BUILDING, IT WAS ADDED TO THE LIST OF HISTORICAL BUILDINGS IN SALEM IN 1990.

EARLIER TENANTS IN THE BUILDING INCLUDED MILLER HAYDEN OF THE REAL SILK HOSIERY COMPANY, FRED BINYON - OPTOMETRIST AND ATTORNEY C.F. GILLETTE.

THE EXISTING ROOF IS A 5-PLY BUILT-UP ASPHALT ROOFING, THE EXISTING CANOPY APPEARS TO HAVE BEEN ADDED ON WITH THE REMODEL OF 1926.

MA VALISE BUILDING

379-383 STATE STREET SALEM, OREGON 97301 EXTERIOR RENOVATION

DESIGN TEAM

OWNER: MA VALISE 379 STATE STREET SALEM, OREGON 97301 PH: 503-371-2234 CONTACT:

JANET OGDAHL

AC + Co ARCHITECTURE COMMUNITY 363 STATE STREET SALEM, OREGON 97301 PH: 503-581-4114 FAX: 503-581-3655 CONTACT: ALAN COSTIC AIA EMAIL: acostic@accoac.com GARY GUNVILLE AIA

EMAIL: ggunville@accoac.com

SHEET INDEX

ARCHITECTURAL

TITLE SHEET / PROJECT INFORMATION / SITE PLAN

3D VIEWS

GROUND FLOOR DEMOLITION PLAN SOUTH ELEVATION DEMOLITION

GROUND FLOOR PLAN SOUTH ELEVATION

CANOPY DETAILS

PROJECT INFORMATION

GENERAL

EXISTING RETAIL/COMMERCIAL OFFICE BUILDING PROJECT NUMBER: 2019.0056


STATE OF OREGON 2014 STRUCTURAL SPECIALTY CODE, AMENDMENTS BASED ON 2012 IBC

PRINCIPAL ARCHITECT: ALAN COSTIC, AIA


PROJECT DESCRIPTION: EXTERIOR RENOVATION OF EXISTING BUILDING INCLUDES NEW METAL CANOPY, GATE, TRANSOM WINDOW GLAZING, WOOD RESTORATION, PAINTING. ALL MECHANICAL, PLUMBING AND ELECTRICAL WORK IS DESIGN/BUILD AND

NOT INCLUDED IN THIS SCOPE OF WORK.

VICINITY MAP

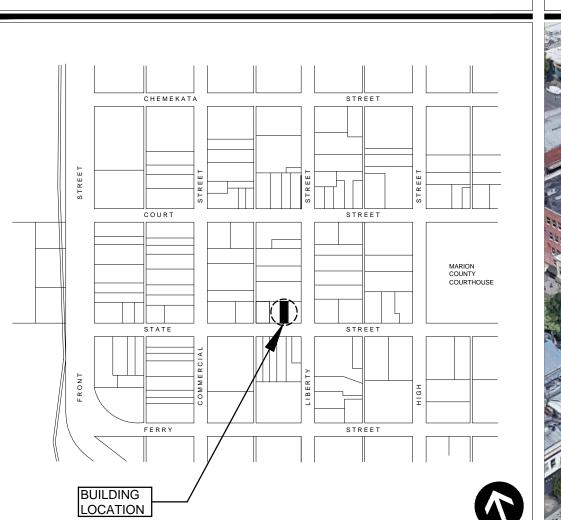

AERIAL VIEW

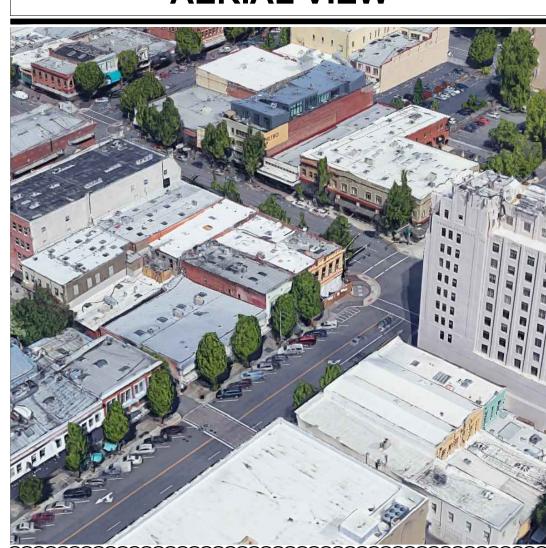

SYMBOL LEGEND

(NOT ALL SYMBOLS MAY BE USED IN THESE DRAWINGS) **NORTH ARROW**

NUMBER

WINDOW TAG

— PAGE NUMBER


ROOM NAME AND

----- ELEVATION NUMBER INTERIOR ELEVATION INDICATOR

REFERENCE NOTE

GRID NOTE INDICATOR

INDICATOR

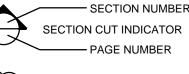

DETAIL INDICATOR

REVISION CLOUD WITH REVISION NUMBER

6'-0" FLOOR ELEVATION

SPOT ELEVATION

PROPERTY INFORMATION

SALEM, BLOCK 33, LOT 4, ACRES 0.061

PROJECT LOCATION: 379-383 STATE STREET, SALEM OREGON 97301

TAX MAP: 379-383 STATE STREET - 073W27AB06400

SUBDIVISION: 78771, SALEM

LEGAL DESCRIPTION:

RETAIL AREA:

UPPER FLOOR:

CB - CENTRAL BUSINESS DISTRICT WITH SALEM ZONING: DOWNTOWN HISTORIC DISTRICT OVERLAY ZONE

RETAIL/RESTAURANT/OFFICE

PARKING: SEC. 806.010. - PROXIMITY OF OFF-STREET PARKING TO USE OR ACTIVITY SERVED. NON-RESIDENTIAL ZONES: WITHIN COMMERCIAL, MIXED-USE, PUBLIC, AND INDUSTRIAL AND EMPLOYMENT ZONES, OTHER THAN THE CB, WSCB, AND SWMU ZONES, REQUIRED OFF-STREET PARKING MAY BE LOCATED WITHIN 800 FEET OF THE DEVELOPMENT SITE CONTAINING THE USE OR ACTIVITY IT SERVES. PARKING SUMMARY: 3902 SF / 350 = 11 STALLS REQUIRED

RESTAURANT/BAR AREA: 1114 SF / 250 = 5 ALLOWABLE HEIGHTS & AREAS

CONSTRUCTION TYPE: VB NON-SPRINKLERED OCCUPANCIES: B, M, A-2 **EXISTING FLOOR AREA:** GROUND FLOOR:

2486 SF (5016 SF TOTAL)

SHEET

PROJECT

original signed and sealed documents prepared by copy of the documents transmitted by mail, fax, electronically or otherwise, the original signed and

2019.0056

JUNE 7, 2019

sealed documents shall govern.

JOB NO.:

DRAWN:

SUBMITTALS:

REVISIONS:

HISTORIC REVIEW 6-7-19

CITY OF SALEM 6-20-19 /1

ARCHITECTURE

COMMUNITY

MA VALISE - EXTERIOR

Salem, OR 97301-3533


RENOVATION

379-383 STATE STREET

SALEM, OREGON 97301

INFORMATION

P: 503.581.4114

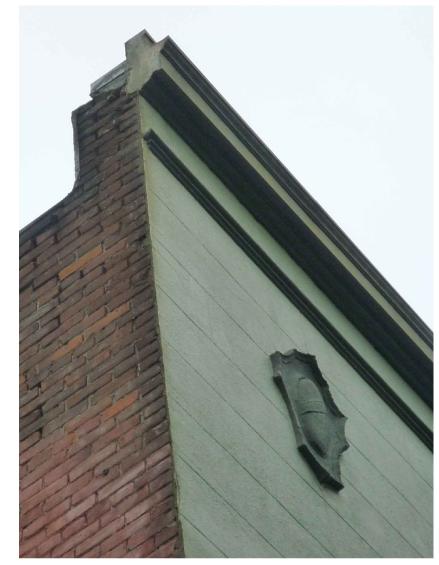

EXISTING PARAPET CAP



EXISTING SOUTH FACE



EXISTING SOUTH FACE BELOW CANOPY



4859
GARY GUNVILLE
SALEM, OREGON
OF OREIGN

In the event conflicts are discovered between the original signed and sealed documents prepared by the Architects and/or their Consultants, and any copy of the documents transmitted by mail, fax, electronically or otherwise, the original signed and sealed documents shall govern.

JOB NO.: 2019.0056

HISTORIC REVIEW 6-7-19

DATE: JUNE 7, 2019

DRAWN: GEG SUBMITTALS:

REVISIONS:



COMMUNITY


363 State Street Salem, OR 97301-3533 P: 503.581.4114 www.accoac.com

MA VALISE - EXTERIOR RENOVATION 379-383 STATE STREET SALEM, OREGON 97301

EXTERIOR 3D VIEW - PHOTOS

SHEET

A0.2

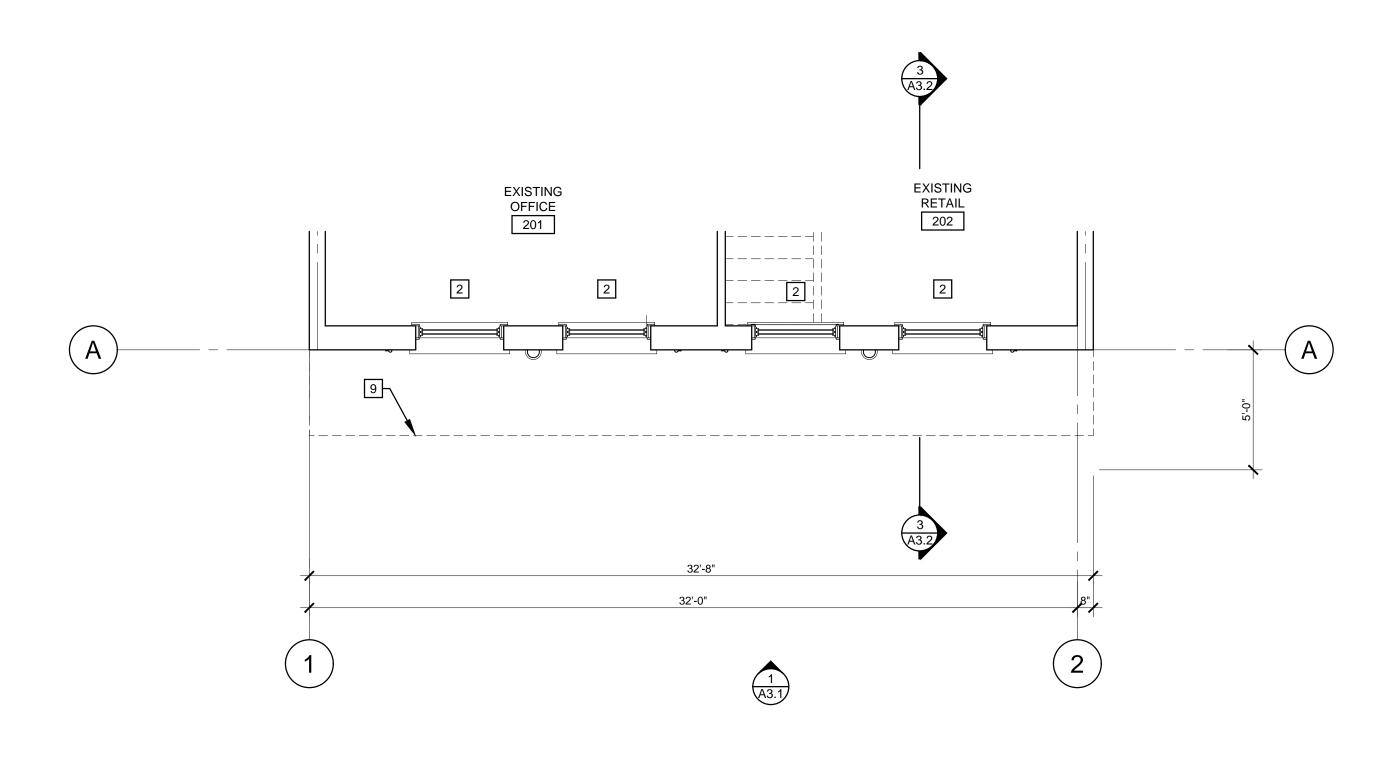


 (A)
 2'-3"
 2'-11"
 2'-10"
 2'-10"
 2'-10"
 2'-11"
 1'-1"
 2'-11"
 2'-10"
 2'-10"
 2'-10"
 2'-11"

 V.F.
 V.F.

SECOND FLOOR/CANOPY PLAN



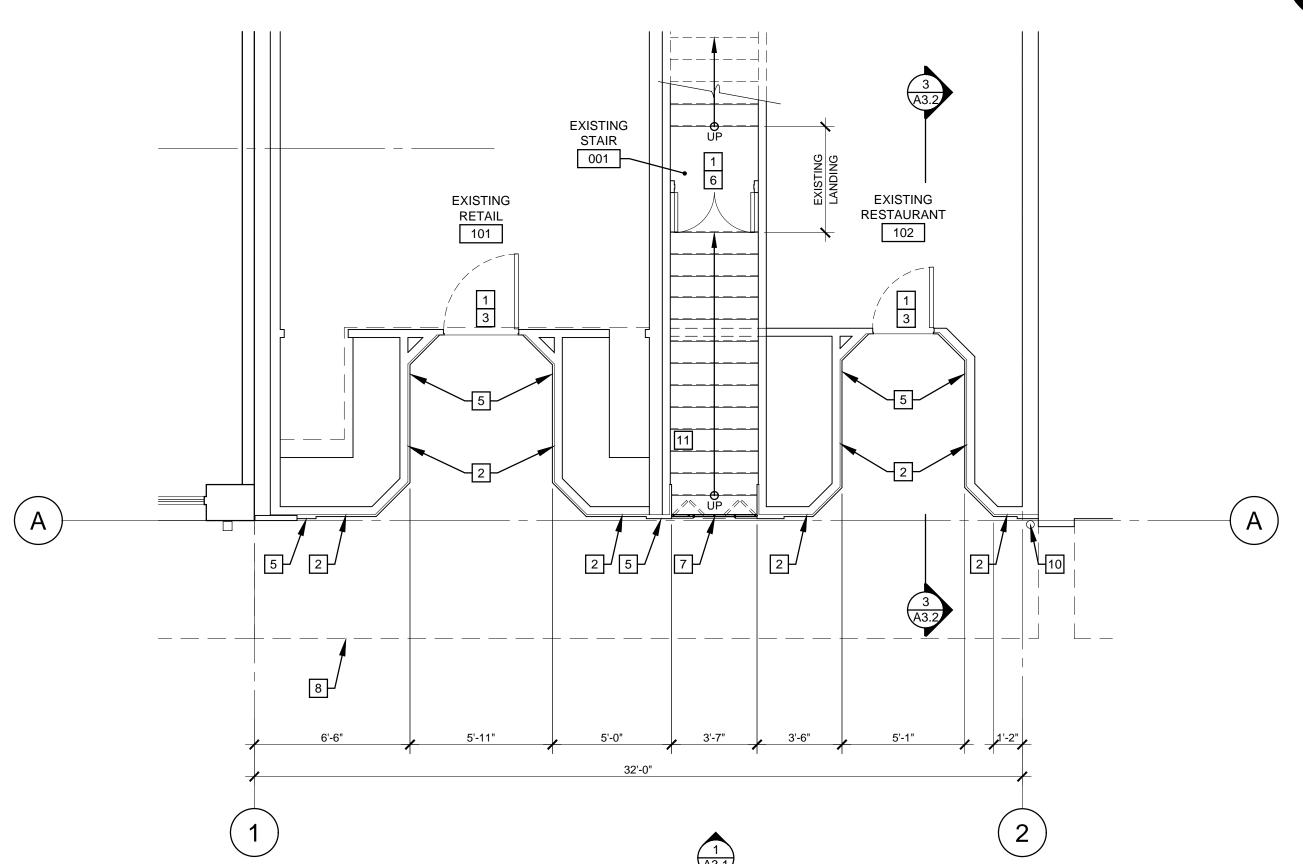

MEZZANINE LEVEL/TRANSOM WINDOW PLAN SCALE: 1/4" = 1'-0"

GENERAL NOTES:

- 1. GENERAL NOTES APPLY TO ALL DRAWINGS
- 2. DIMENSIONS ARE TO EXISTING FACE OF WALL AND FACE OF EXISTING MASONRY UNLESS NOTED OTHERWISE.
- 3. DRAWINGS ARE DIAGRAMMATIC ONLY AND SHOULD NOT BE SCALED. NOTIFY ARCHITECT IMMEDIATELY OF ANY DISCREPANCIES OR QUESTIONABLE DIMENSIONS PRIOR TO PROCEEDING WITH AREA OF QUESTIONABLE WORK.
- 4. REFER TO OWNER FOR ALL FINISHES
- 5. REFER TO ELECTRICAL DESIGN BUILD DRAWINGS FOR ADDITIONAL INFORMATION

SYMBOL LEGEND:

EXISTING MASONRY WALL TO REMAIN UNLESS NOTED OTHERWISE

DOOR, FRAME AND HARDWARE, REFER TO DOOR SCHEDULE A8.1

WINDOW TYPE, REFER TO WINDOW SCHEDULE A8.1

DEMOLITION REFERENCE NOTES:

- 1 EXISTING DOOR TO REMAIN, PROTECT IN PLACE DURING CONSTRUCTION
- 2 EXISTING GLAZING, PROTECT IN PLACE DURING CONSTRUCTION
- 3 EXISTING EXTERIOR DOOR TO BE REFINISHED
- EXISTING GLAZING TO BE REMOVED AT TRANSOMS, EXISTING FRAMES AND TRIM TO BE REPAIRED AND PAINTED
- 5 EXISTING MARBLE VENEER, PROTECT IN PLACE DURING CONSTRUCTION
- 6 EXISTING DOUBLE DOOR AT LANDING TO BE PAINTED, PROVIDE NEW LOCKING HARDWARE
- 7 EXISTING METAL GATE TO BE REMOVED
- 8 LINE OF EXISTING CANOPY ABOVE
- 9 EXISTING METAL CANOPY TO BE REMOVED
- 10 EXISTING METAL DOWNSPOUT TO BE REMOVED
- 11 EXISTING STAIRS TO REMAIN OPEN DURING CONSTRUCTION

copy of the documents transmitted by mail, fax, electronically or otherwise, the original signed and sealed documents shall govern.

JOB NO.: 2019.0056


DATE: JUNE 7, 2019

SALEM, OREGON OF OREGON

original signed and sealed documents prepared by the Architects and/or their Consultants, and any

DRAWN: SUBMITTALS: HISTORIC REVIEW 6-7-19

REVISIONS:

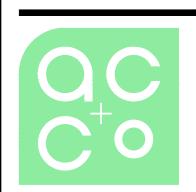

ARCHITECTURE COMMUNITY

363 State Street Salem, OR 97301-3533 P: 503.581.4114


MA VALISE - EXTERIOR RENOVATION 379-383 STATE STREET SALEM, OREGON 97301


DEMOLITION FLOOR PLANS


SHEET

FIRST FLOOR PLAN



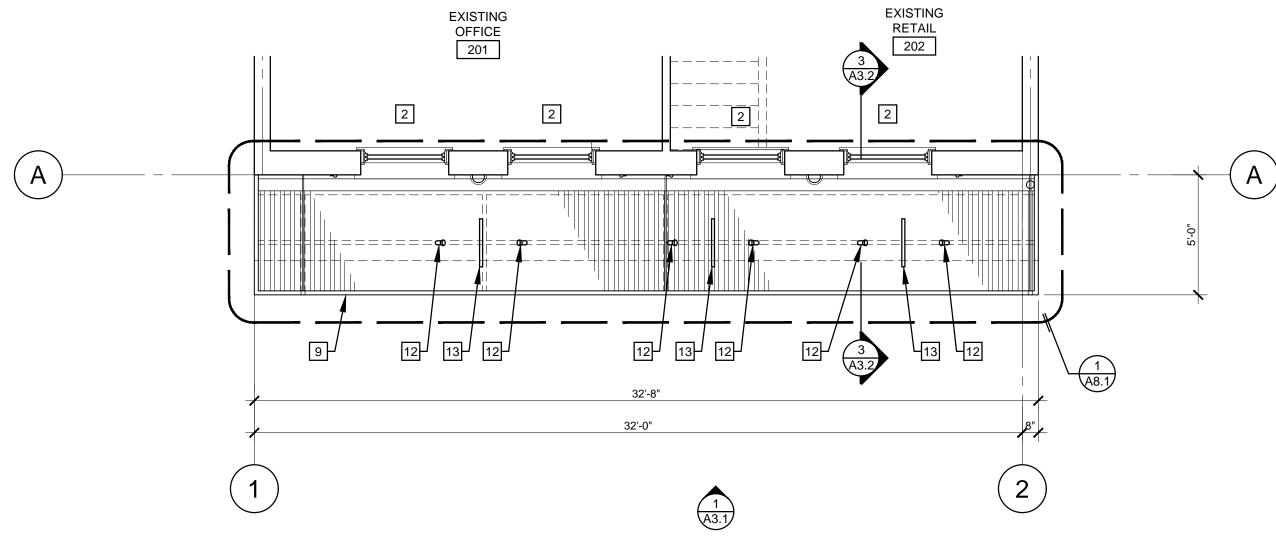

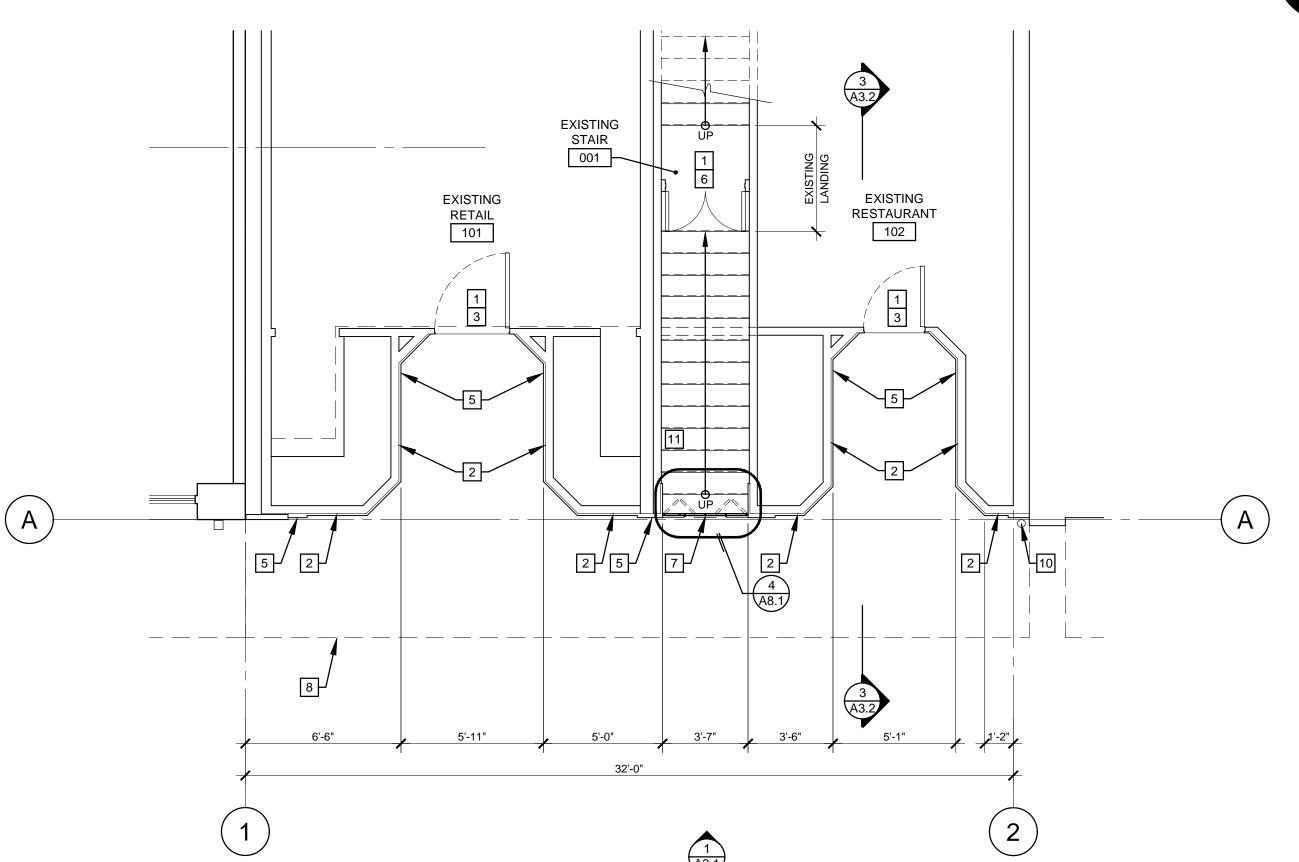

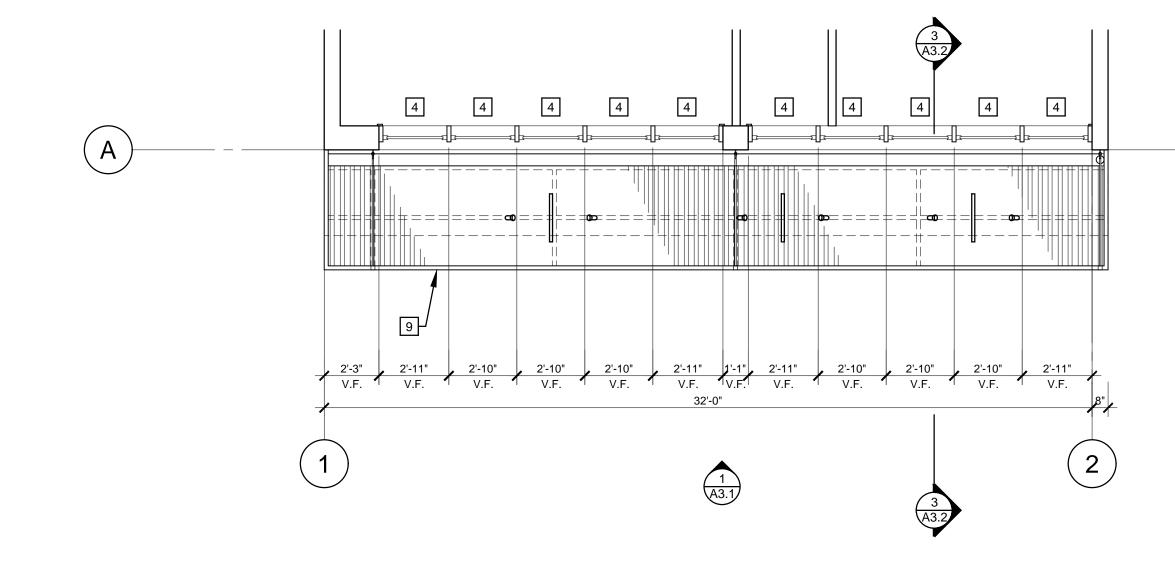

MEZZANINE LEVEL/TRANSOM WINDOW PLAN

SCALE: 1/4" = 1'-0"

GENERAL NOTES:

GENERAL NOTES APPLY TO ALL DRAWINGS

2. DIMENSIONS ARE TO EXISTING FACE OF WALL AND FACE OF EXISTING MASONRY UNLESS NOTED OTHERWISE.

 DRAWINGS ARE DIAGRAMMATIC ONLY AND SHOULD NOT BE SCALED. NOTIFY ARCHITECT IMMEDIATELY OF ANY DISCREPANCIES OR QUESTIONABLE DIMENSIONS PRIOR TO PROCEEDING WITH AREA OF QUESTIONABLE WORK.

4. REFER TO OWNER FOR ALL FINISHES

5. REFER TO ELECTRICAL DESIGN BUILD DRAWINGS FOR ADDITIONAL INFORMATION

REFERENCE NOTES:

1 EXISTING DOOR TO REMAIN, PROTECT IN PLACE DURING CONSTRUCTION

2 EXISTING GLAZING, PROTECT IN PLACE DURING CONSTRUCTION

3 EXISTING EXTERIOR DOOR TO BE REFINISHED

NEW GLAZING, PROVIDE TEMPERED CLEAR GLASS, EXISTING FRAMES AND TRIM TO BE REPAIRED AND PAINTED

5 EXISTING MARBLE VENEER, PROTECT IN PLACE DURING CONSTRUCTION

6 EXISTING DOUBLE DOOR AT LANDING TO BE PAINTED, PROVIDE NEW LOCKING HARDWARE

7 NEW METAL GATE, PAINT

8 LINE OF NEW CANOPY ABOVE

9 NEW METAL CANOPY, PAINT

10 NEW METAL DOWNSPOUT, PAINT

11 EXISTING STAIRS TO REMAIN OPEN DURING CONSTRUCTION

12 NEW SIGN LIGHTING, MOUNT TO UNDERSIDE OF CANOPY

13 NEW BLADE SIGN, MOUNT TO UNDERSIDE OF CANOPY

SYMBOL LEGEND:

----- OTHERWISE

EXISTING MASONRY WALL TO REMAIN UNLESS NOTED

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JOB NO.: 2019.0056

sealed documents shall govern.

DATE: JUNE 7, 2019

SALEM, OREGON OF OREGON

DRAWN: G SUBMITTALS: HISTORIC REVIEW 6-7-19

REVISIONS:



ARCHITECTURE COMMUNITY

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RENOVATION

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FLOOR PLANS


SHEET

A2.1

FIRST FLOOR PLAN


SECOND FLOOR/CANOPY PLAN



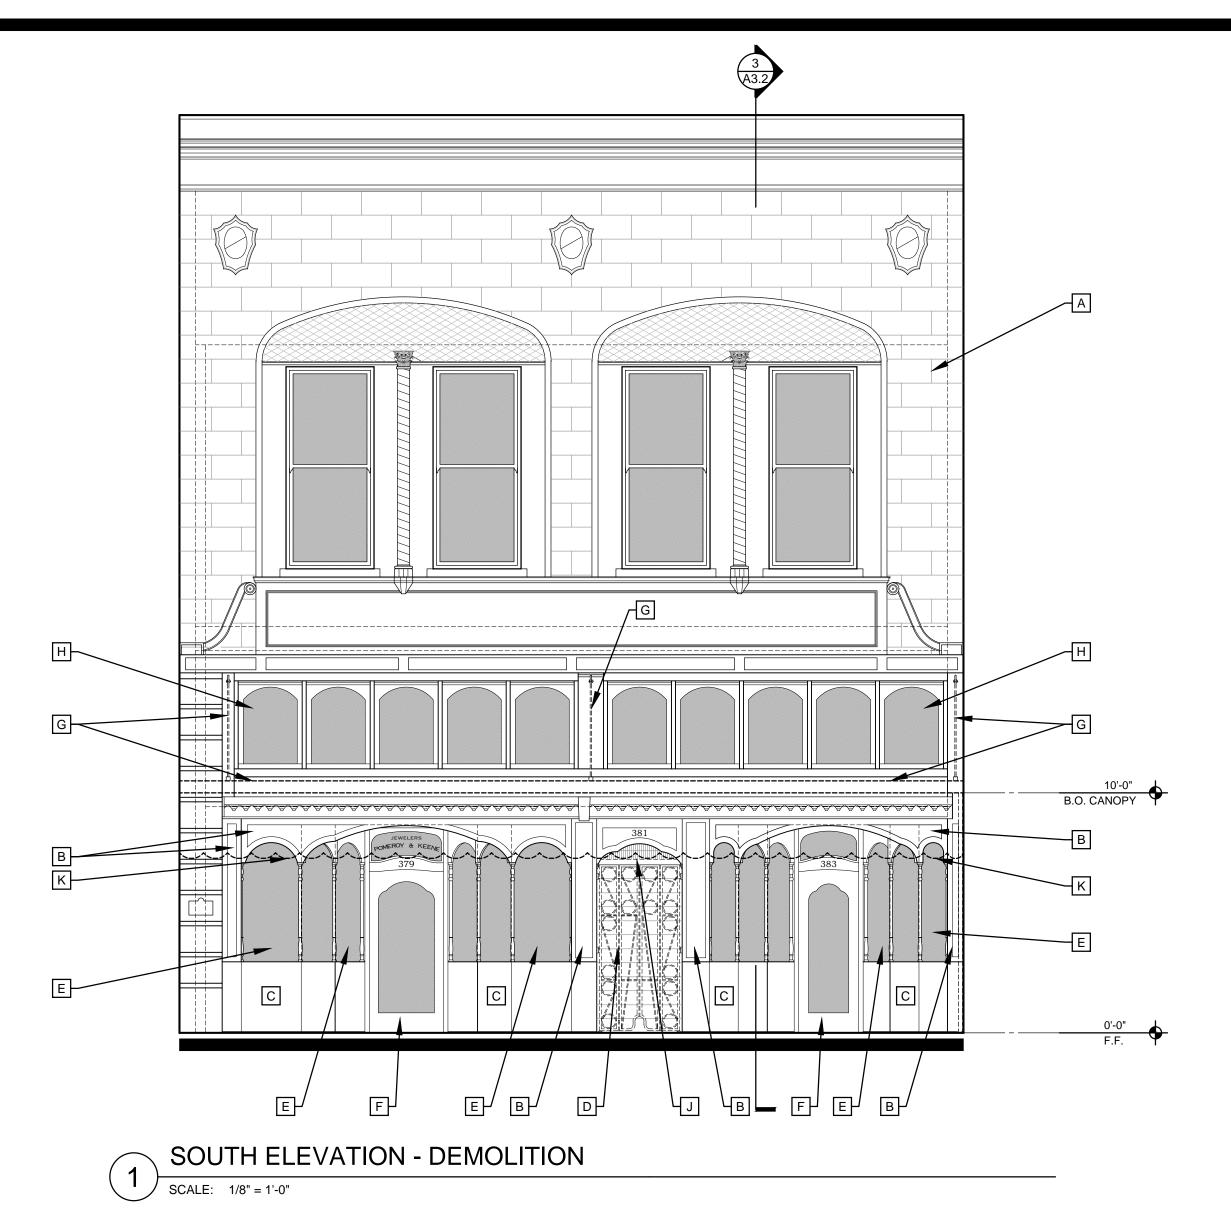

DEMOLITION REFERENCE NOTES:

- A EXISTING EXTERIOR TO REMAIN, PREP FOR PAINT
- B EXISTING WOOD TRIM AND PANELS TO BE REFINISHED
- C EXISTING MARBLE WAINSCOTING TO REMAIN
- D EXISTING METAL GATE TO BE REMOVED
- E EXISTING GLAZING, PROTECT DURING CONSTRUCTION
- F EXISTING DOORS TO BE REFINISHED
- EXISTING CANOPY AND BRACE RODS TO BE REMOVED, EXISTING EYE-BOLT TO REMAIN IN WALL
- H EXISTING GLAZING AT TRANSOMS TO BE REMOVED
- J EXISTING PLEXI-GLASS SCREEN TO BE REMOVED AT ENTRY TO STAIR
- K EXISTING FABRIC AWNING AND BLADE SIGNS TO BE REMOVED

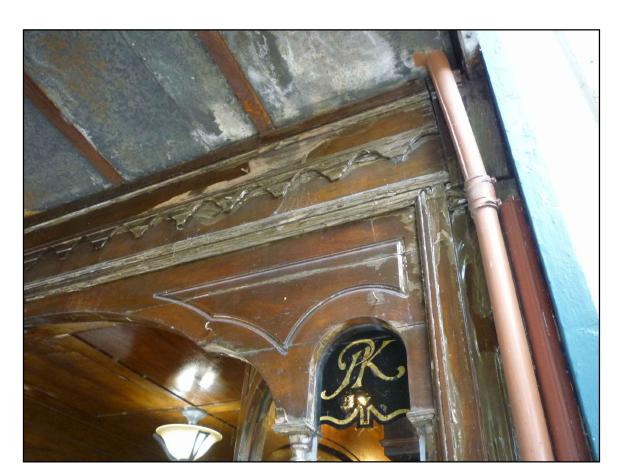

A. EXISTING WOOD PANELING AND TRIM TO BE REFINISHED. DOWNSPOUT AND CANOPY TO BE REMOVED



B. EXISTING WOOD PANELING AND TRIM TO BE REFINISHED. PLEXI-GLASS SCREEN TO BE REMOVED




C. WALLACE ENTRANCE; EXISTING WOOD PANELING AND TRIM TO BE REFINISHED. LIGHT FIXTURE TO BE REMOVED AND REPLACED



D. MA VALISE ENTRANCE; EXISTING WOOD PANELING AND TRIM TO BE REFINISHED. LIGHT FIXTURE TO BE REMOVED AND REPLACED



E. EXISTING TRANSOM WINDOWS, REPLACE GLASS, REPAIR WOOD FRAMES AND TRIM, PAINT

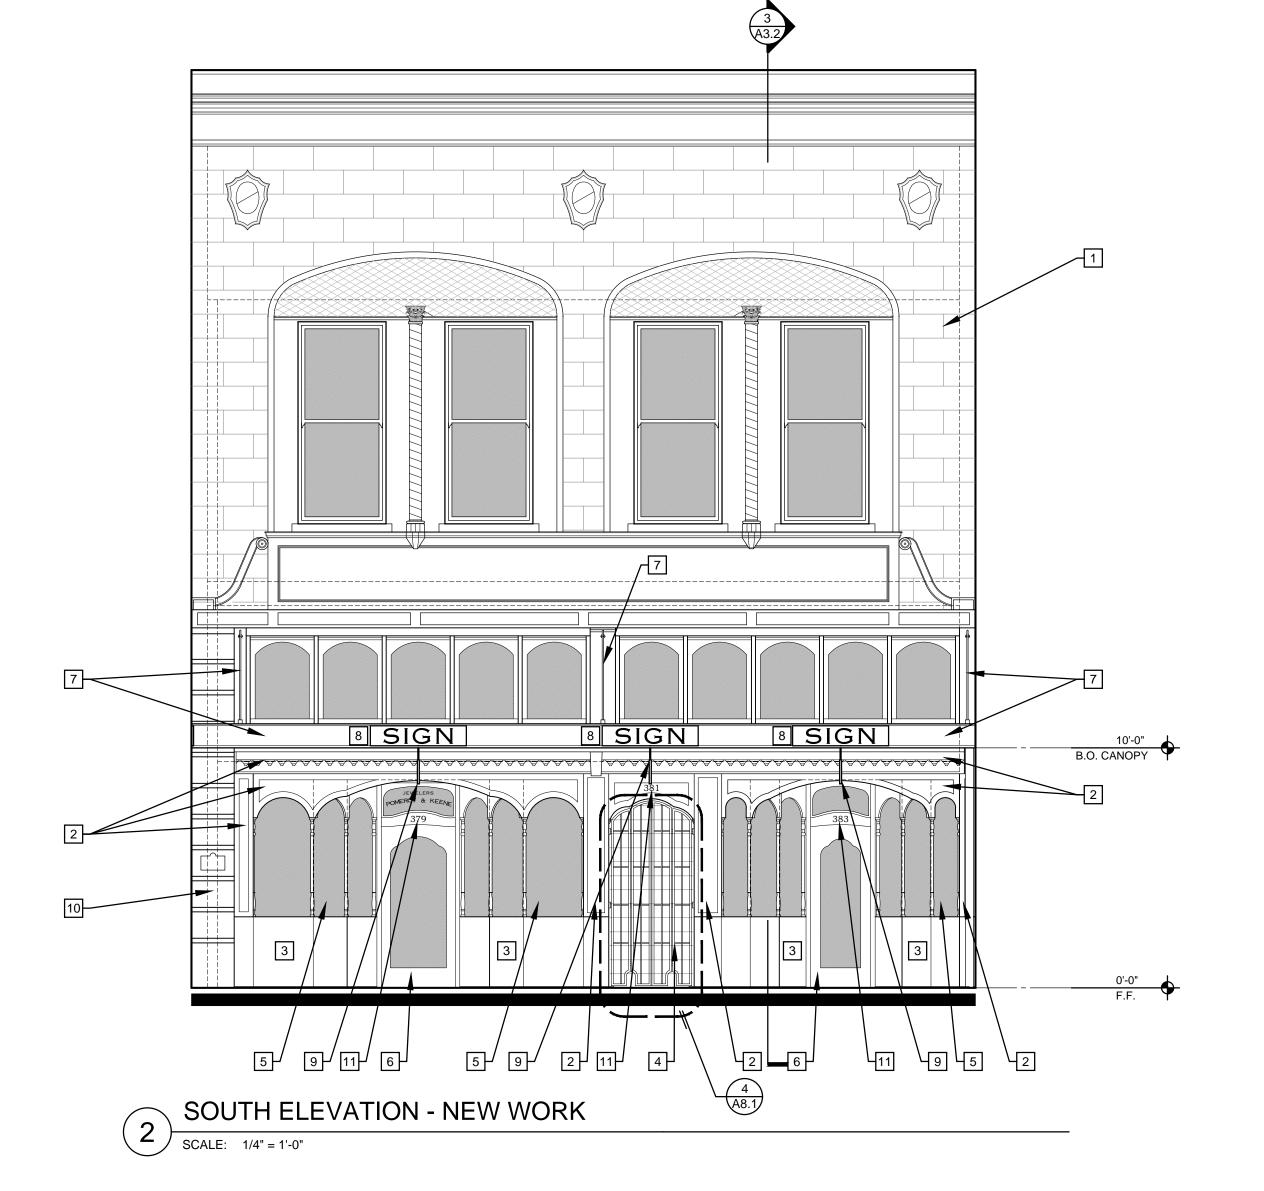

NEW WORK REFERENCE NOTES:

- 1 EXISTING EXTERIOR TO BE PAINTED, COLORS: TBD
- 2 EXISTING WOOD TRIM AND PANELS TO BE REFINISHED
- 3 EXISTING MARBLE WAINSCOTING TO REMAIN
- 4 NEW METAL GATE (A8.1)

 5 EXISTING GLAZING, PROTECT DURING CONSTRUCTION
- 6 EXISTING DOORS TO BE REFINISHED
- 7 NEW METAL CANOPY AND BRACE RODS, PAINT 28 NEW SIGNS ON CANOPY FACE, UNDER SEPARATE PERMIT BY OWNER
- 9 NEW BLADE SIGNS ON CANOPY SOFFIT, UNDER SEPARATE PERMIT BY OWNER

11 EXISTING ADDRESS NUMBERS TO BE REPLACED, STYLE: TBD

10 EXISTING CONCRETE BLOCKS TO REMAIN, PAINT

DRAWN:

SUBMITTALS:

REVISIONS:

HISTORIC REVIEW 6-7-19

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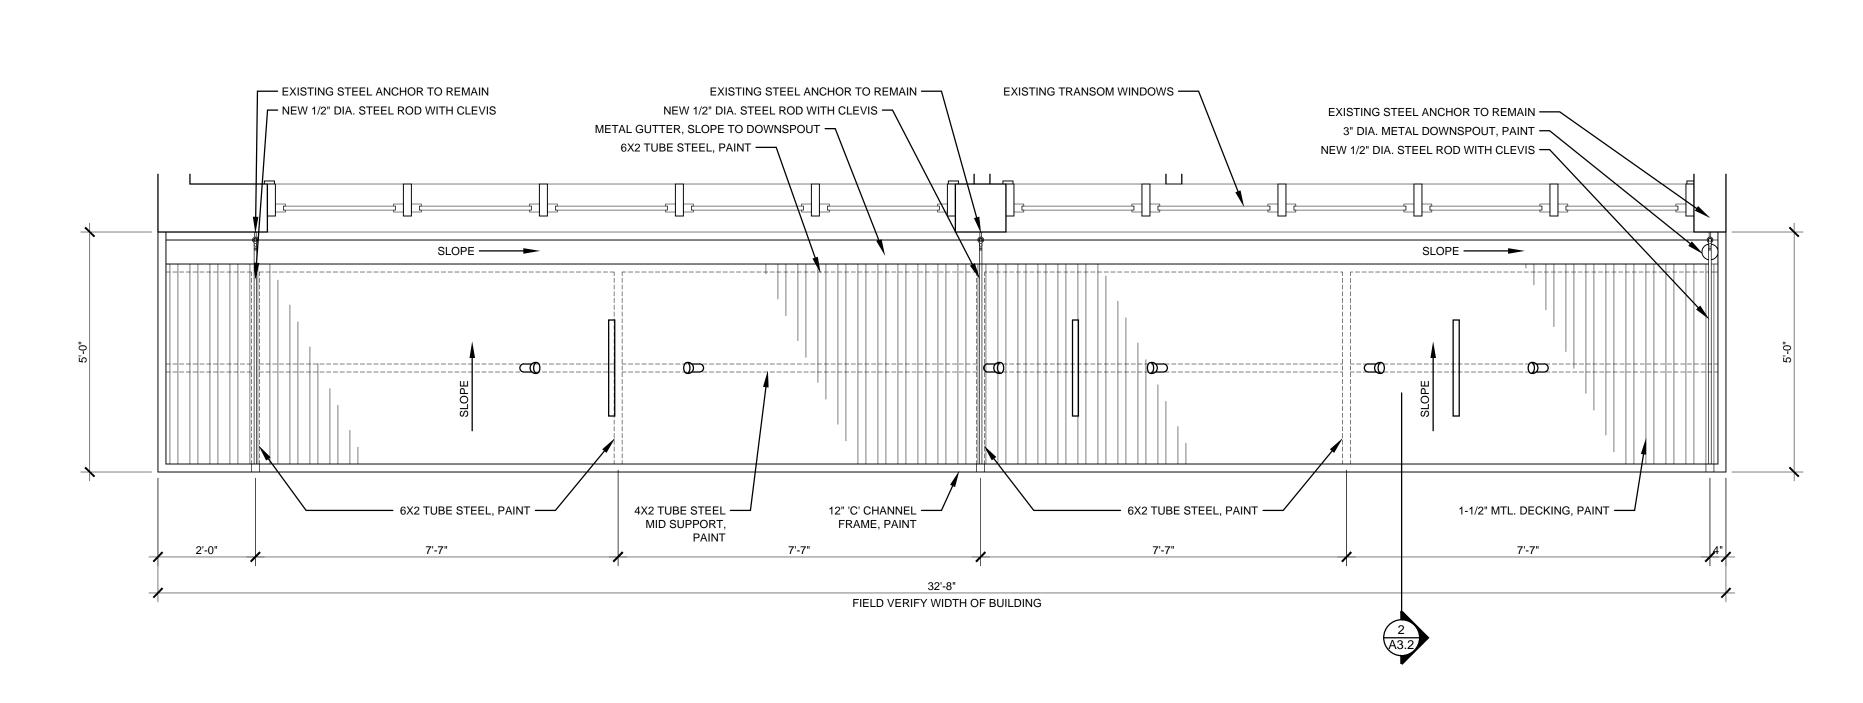
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EXTERIOR ELEVATIONS DEMO AND NEW WORK

SHEET



NEW CANOPY PLAN

SCALE: 1/2" = 1'-0"

 EXISTING EXTERIOR WALL - EXISTING EYE BOLT TO REMAIN MEW 1/2" DIA. STEEL ROD AND CLEVIS ***** PRE-FINISHED METAL FLASHING OVER 'C' CHANNEL 6" 'C' CHANNEL WITH GALV. LAG BOLT TO EXISTING BEAM METAL DECKING WITH 1/2":1' SLOPE, **_--------**STEEL PLATE CONNECTOR - WELD
TO CANOPY FRAME 12" 'C' CHANNEL, PAINT · 2" X 2" STEEL ANGLE, PAINT **~----**EXISTING MEZZ. — 10'-0" B.O.C. — WATERPROOF LIGHT FIXTURE BLADE SIGN UNDER SEPARATE

6X2 TUBE STEEL FRAME, PAINT

3" DIA. METAL DOWNSPOUT

NEW METAL CANOPY DETAIL


4" WIDE METAL GUTTER, SLOPE ————

TO DOWNSPOUT

WALL SECTION AT NEW CANOPY

SCALE: 1/2" = 1'-0"

EXISTING ROOF TO REMAIN —

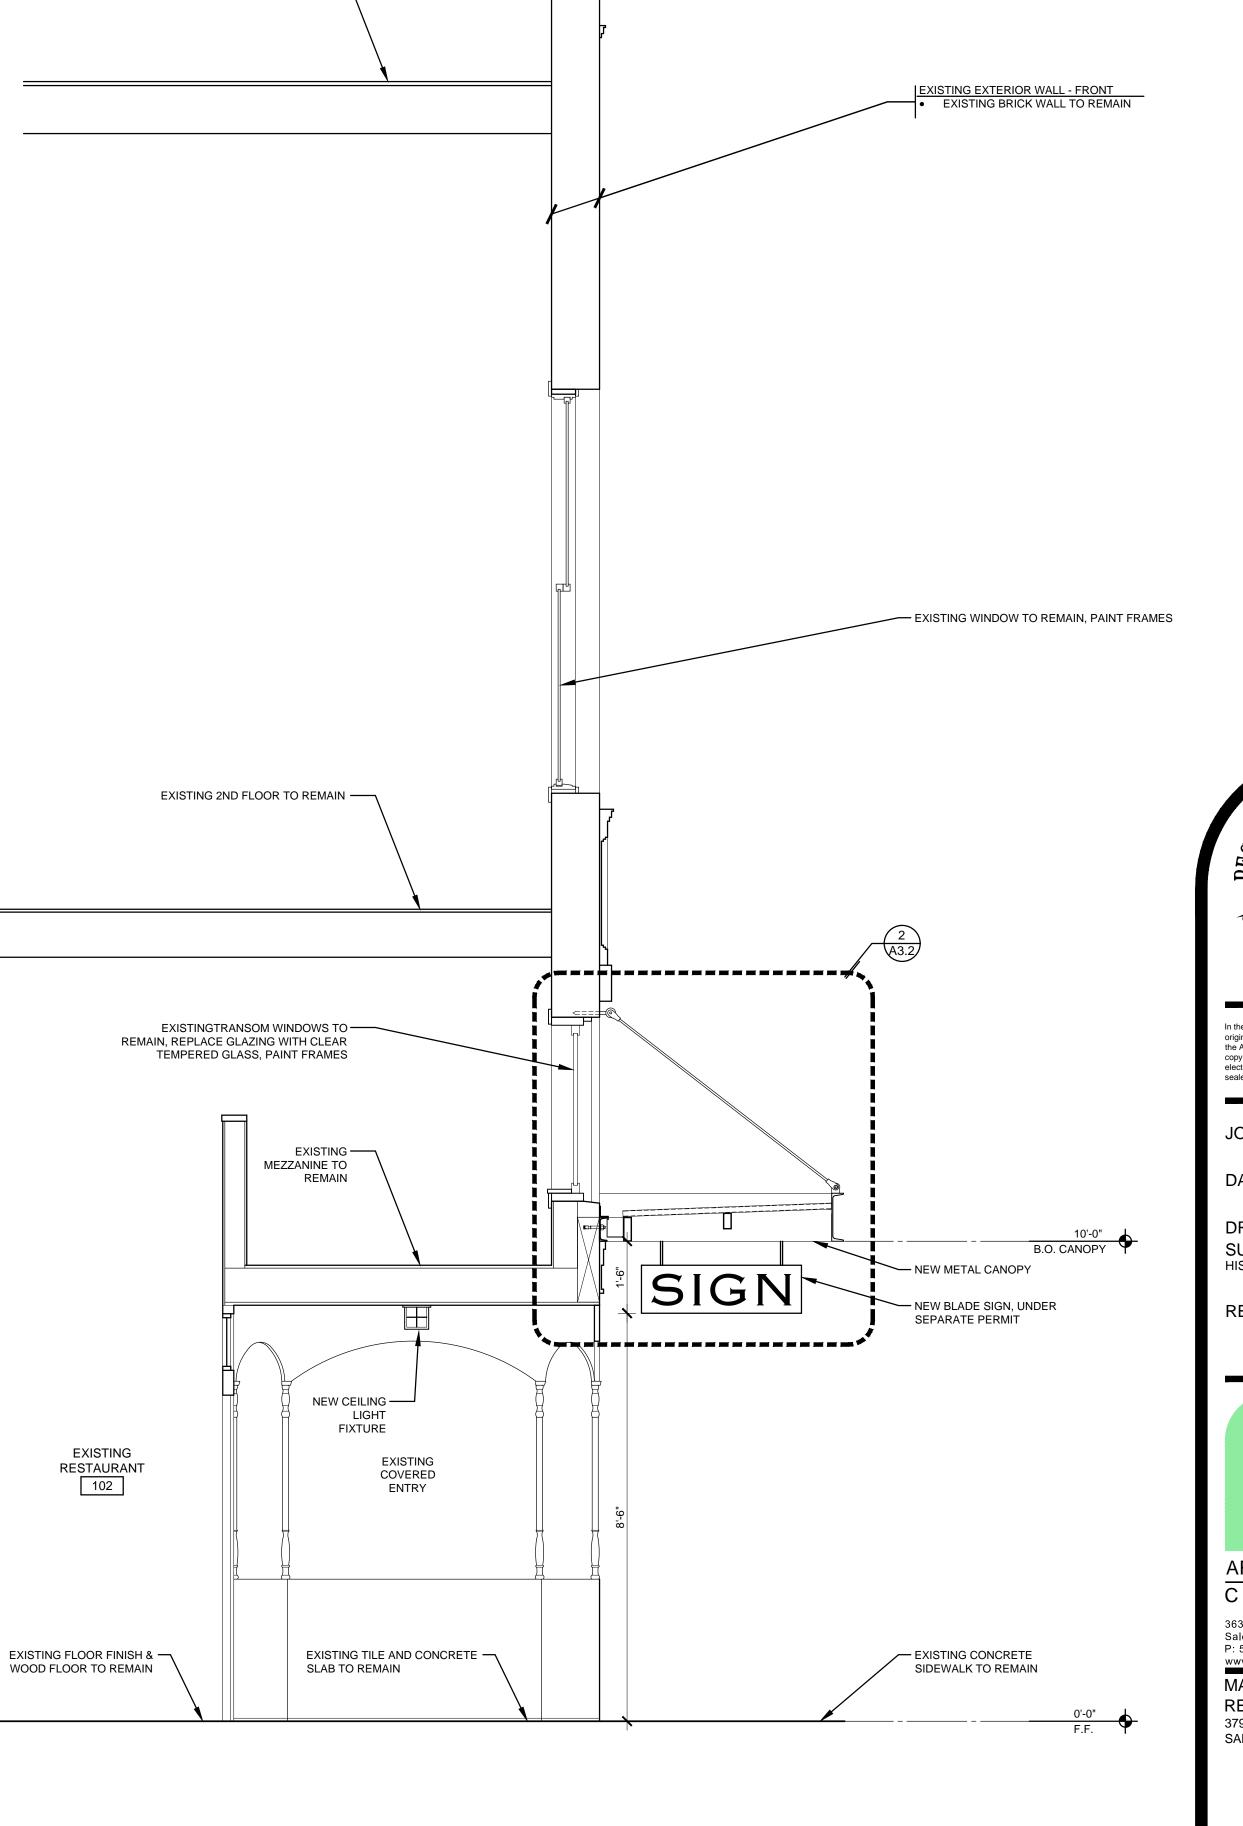

4859
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SALEM, OREGON

OF ORBITAL

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JOB NO.: 2019.0056

DATE: JUNE 7, 2019

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REVISIONS:



ARCHITECTURE C O M M U N I T Y


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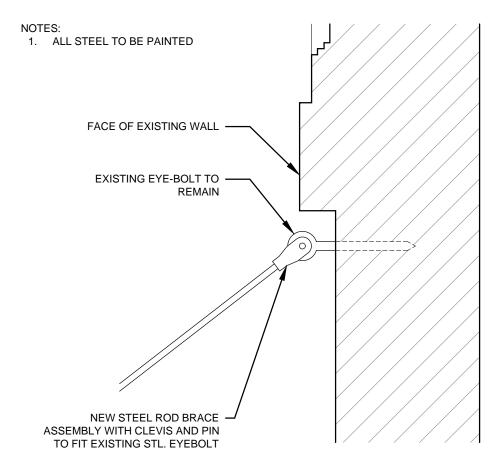
WALL/CANOPY SECTION

SHEET

A3.2




CANOPY ROD BRACE DETAIL SCALE: 1 1/2" = 1'-0"

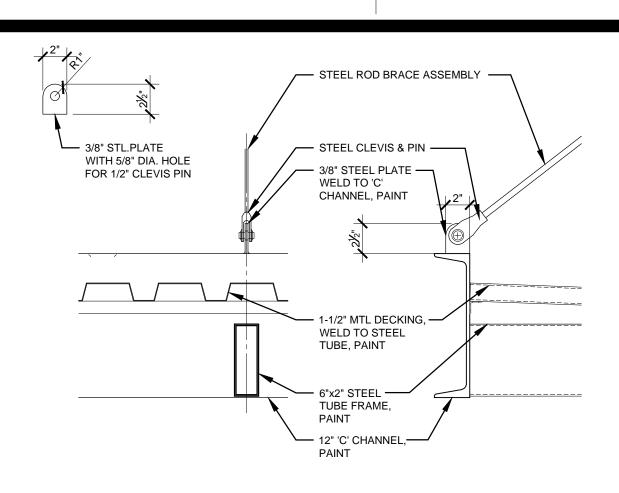


CANOPY ROD BRACE AT EYEBOLT


SCALE: 1 1/2" = 1'-0"

) SCALE: 1 1/2" = 1'-0"

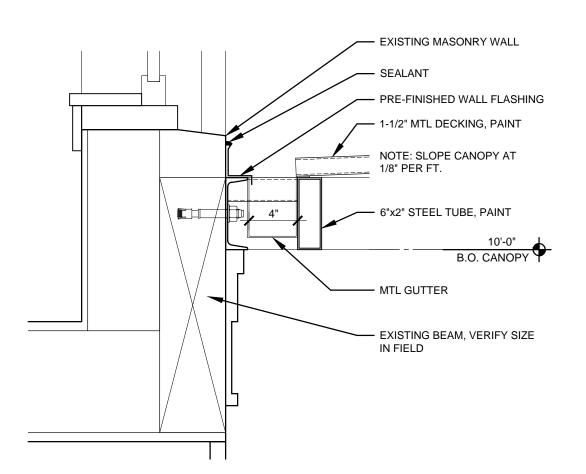

CANOPY CONNECTION AT WALL

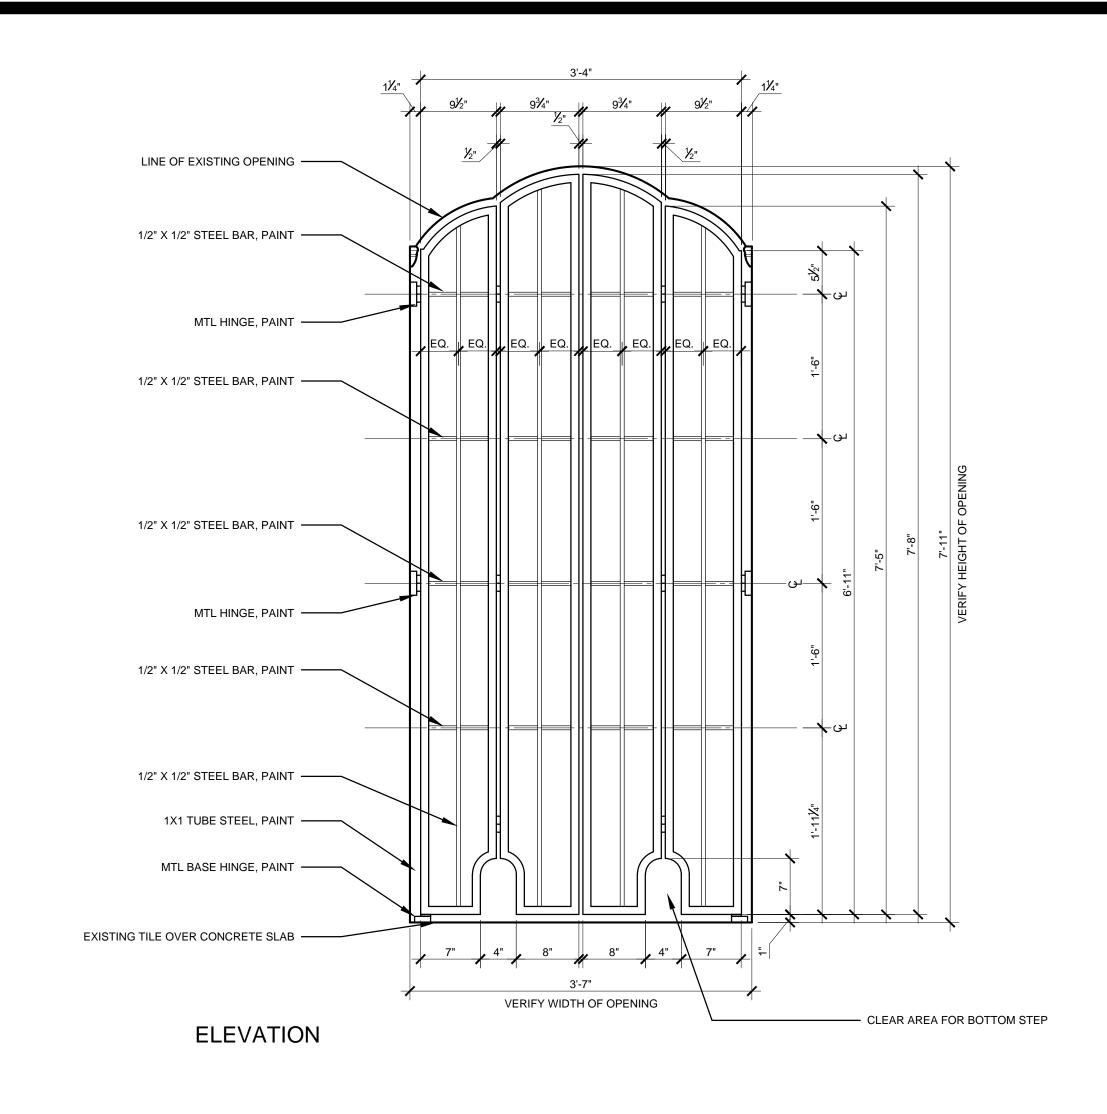

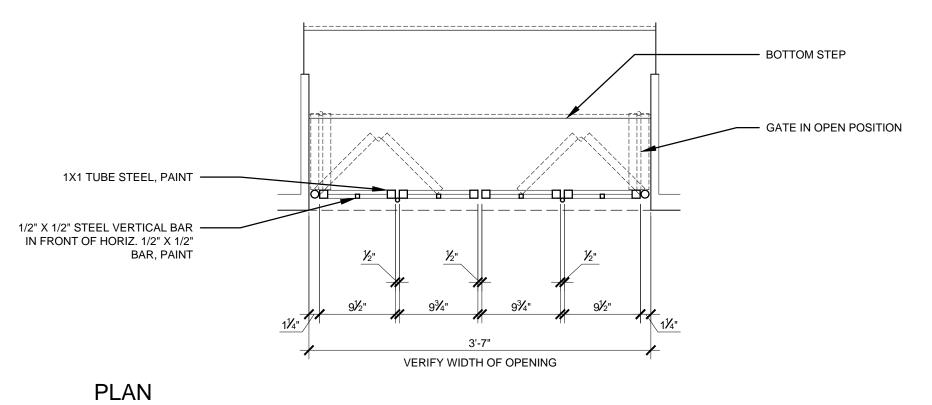

NEW METAL GATE

SCALE: 1" = 1'-0"

VERIFY WIDTH OF OPENING

DRAWN: G
SUBMITTALS:
HISTORIC REVIEW 6-7-19

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JOB NO.: 2019.0056

DATE: JUNE 7, 2019

DRAWN: GEG

REVISIONS:



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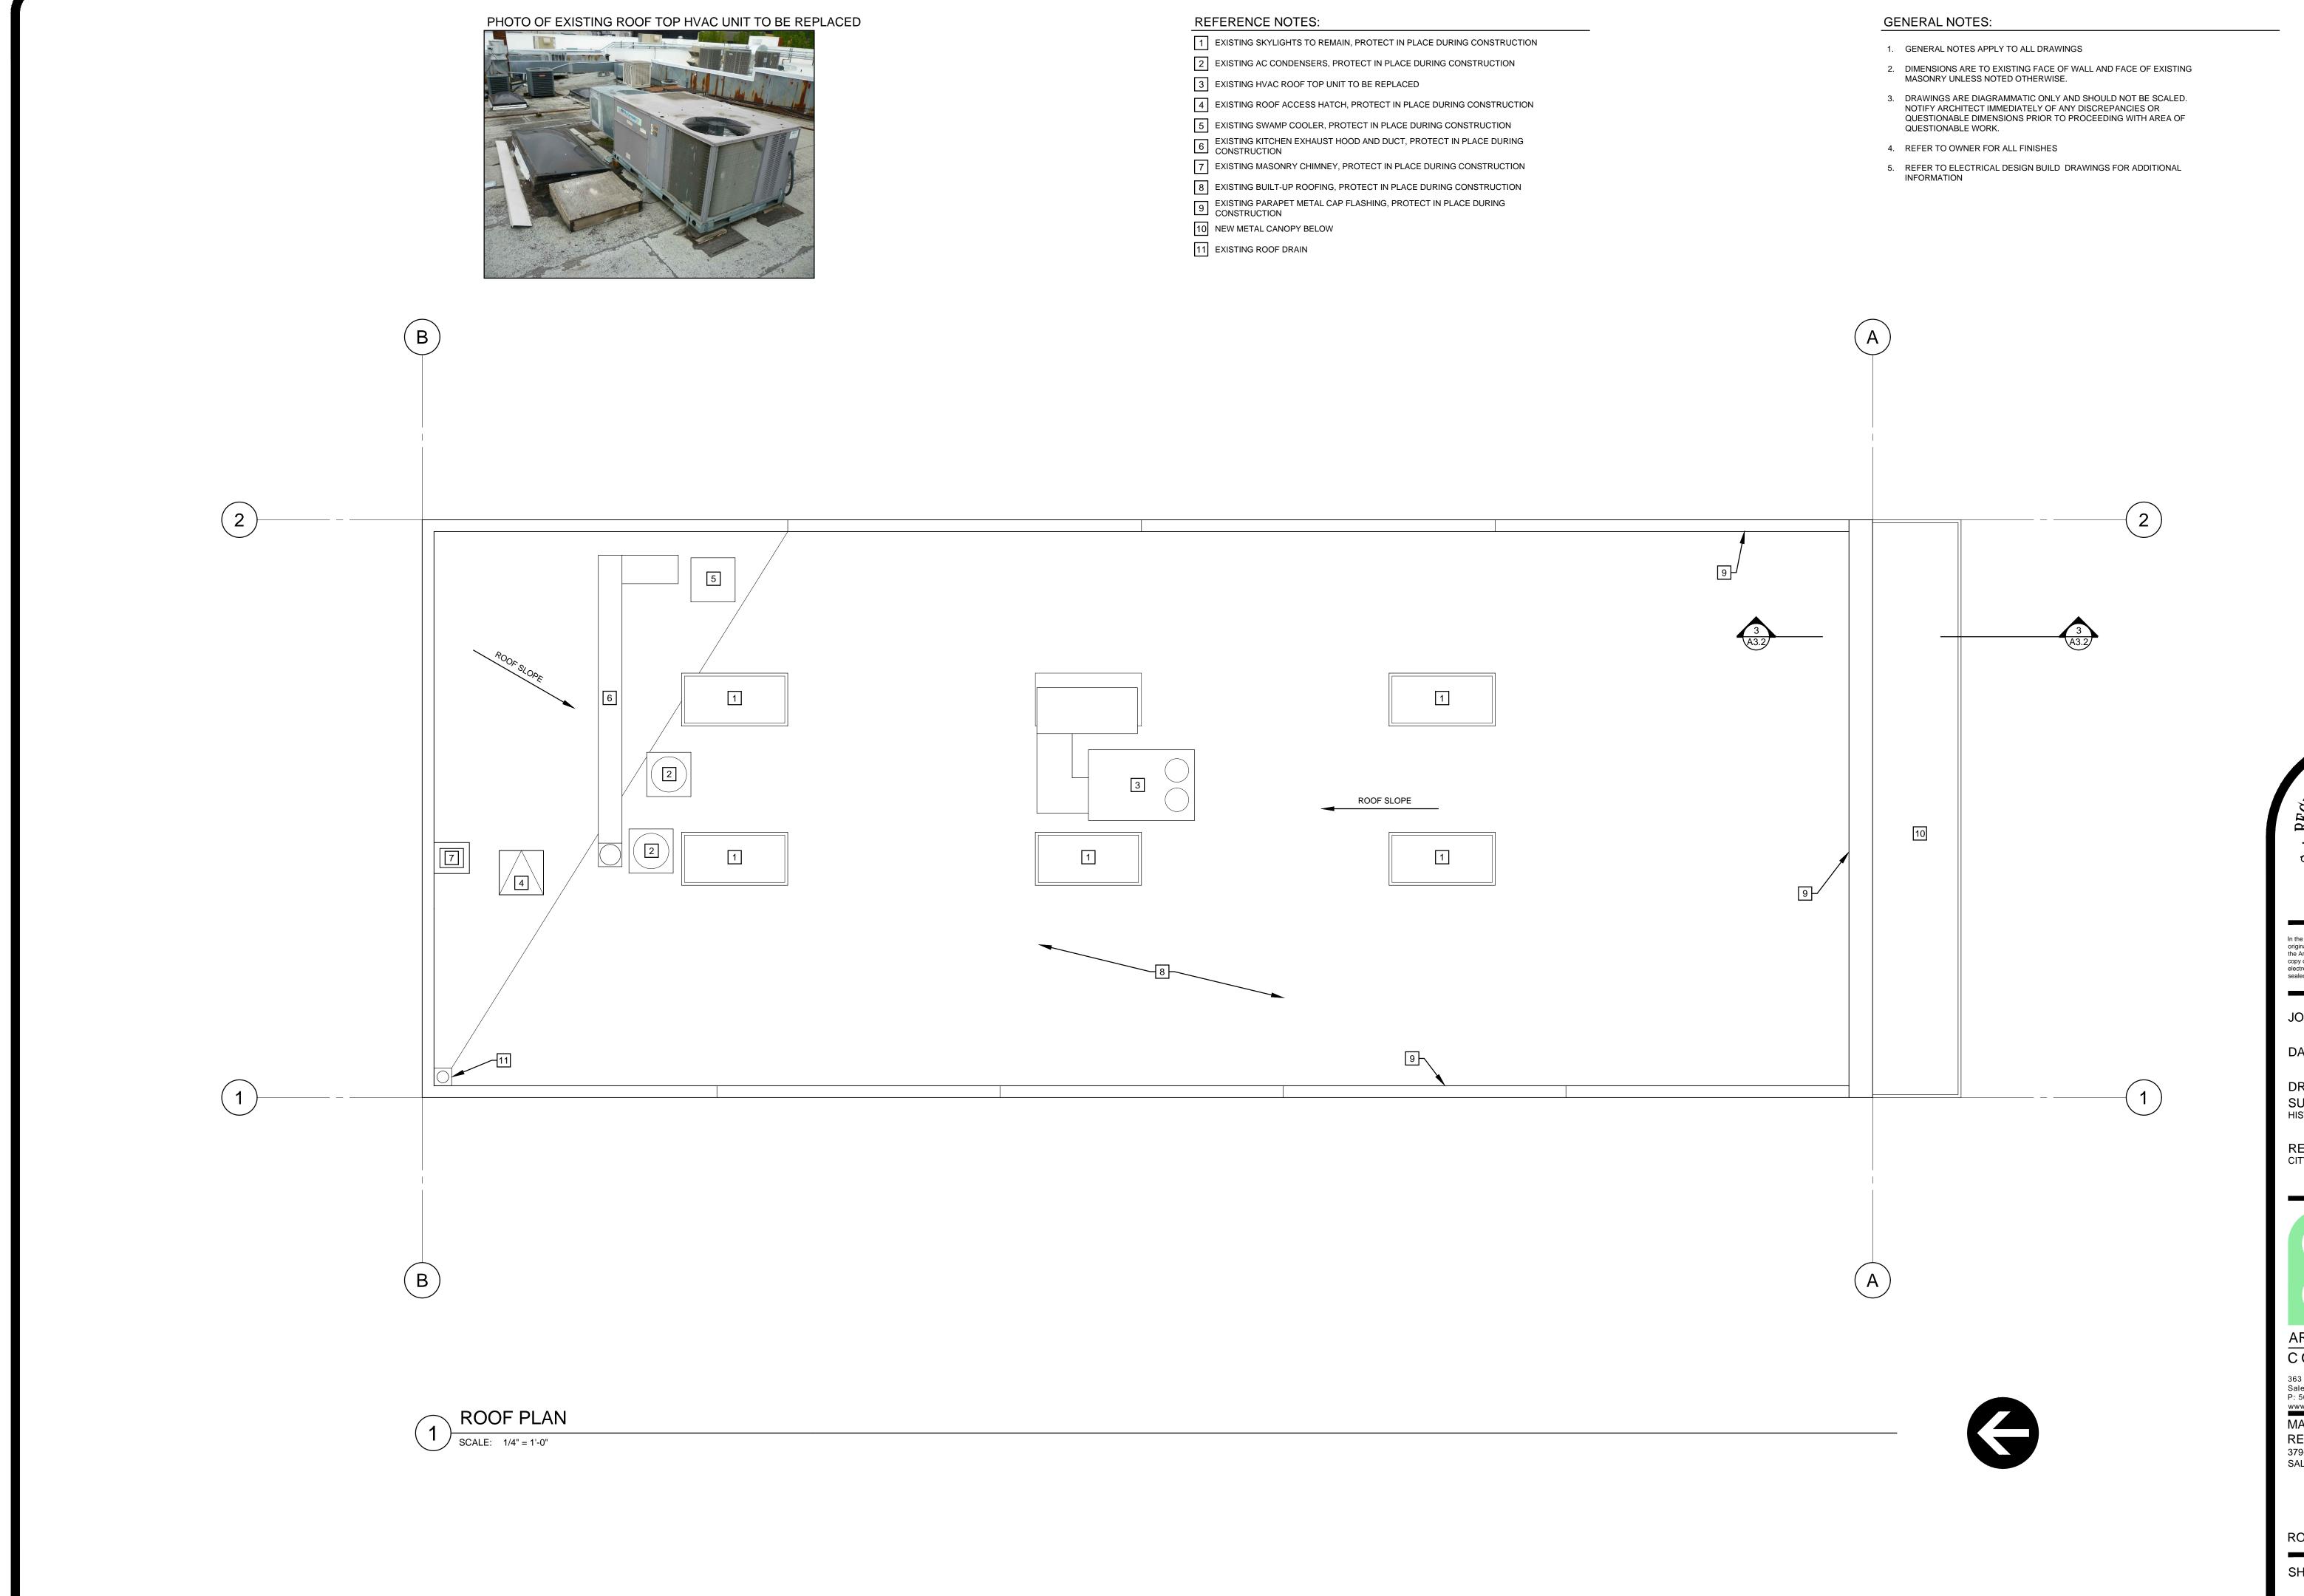
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DETAILS

SHEET

A8.1



SALEM, OREGON

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JOB NO.: 2019.0056

DATE: JUNE 21, 2019

DRAWN: SUBMITTALS: HISTORIC REVIEW 6-7-19

REVISIONS: CITY OF SALEM 6-21-19



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ROOF PLAN

SHEET

Window Assessment – Exterior

Date: 6/14/2019

Building: Ma Valise Building 379-383 State Street

	Location: Transom above entry
	Window Description: Wood window frame with opaque single pane glass. (10) total windows.
	Sill: Wood
	Remove paint Repair Paint and repair
	Replace
	Frame/Trim: Wood
	Remove paint
	Repair Paint and repair
	Replace
	Sash/Muntins/Leading: N/A
	Remove paint
	Repair
	Replace
	Glazing Putty: Replace glazing putty
	% to repair
	% to replace 100
Dimensions of window: 32"w x 42" ht	Glazing: Replace
32 W A 42 III	
	☐ Old New Replace with clear glass
	Broken
Remarks:	Hardware Description: Metal catch at top
Several windows have the top catch missing or broken. Want to	Remove paint
replace with matching metal catches on inside of window. Windows tilt in from the top.	✓ Missing Replace missing

Window Assessment – Interior

Date: 6/14/2019

Building: Ma Valise Building 379-383 State Street

32" x 42" Hardware Description: Metal catch at top Remove paint Missing Replace Ropes/Chains: N/A Replace		Location: Transom above entry
Remove paint Replace Frame/Pulley/Stiles: Wood Remove paint Replace Frame/Pulley/Stiles: Wood Remove paint Replace Sash/Muntins/Leading: N/A Remove paint Replace Trim: Wood Remove paint Replace Trim: Weapir Replace Trim: Wood Remove paint Replace Trim: Replace Trim: Replace Trim: Wood Remove paint Replace Trim: Replace Trim: Wood Remove paint Replace Weatherstripping: None Weatherstripping: None		Wood window frame with opaque single pane
Frame/Pulley/Stiles: Wood Remove paint Replace Sash/Muntins/Leading: N/A Remove paint Replace Trim: Wood Remove paint Replace Dimensions of window: 32" x 42" Hardware Description: Metal catch at top Remove paint Missing Replace Replace Ropes/Chains: N/A Replace Replace Ropes/Chains: N/A Replace Replace Weatherstripping: None		Remove paint Repair Paint and repair
□ Remove paint □ Replace Sash/Muntins/Leading: N/A □ Remove paint □ Repair □ Replace Trim: Wood □ Remove paint □ Repair □ Replace Trim: Wood □ Remove paint □ Replace Hardware Description: Metal catch at top □ Remove paint □ Missing Replace Remove paint □ Replace Remove paint □ Replace Dimensions of window: 32" x 42" Hardware Description: Metal catch at top □ Remove paint □ Missing Replace Remarks: Owner wants to replace the existing glass with clear single pane glass cut to fit into existing wood frames. Windows tilt in from the top		
Sash/Muntins/Leading: N/A Remove paint Repair Replace Trim: Wood Remove paint Replace Trim: Wood Repair Paint and repair Replace Dimensions of window: 32" x 42" Hardware Description: Metal catch at top Remove paint Missing Replace Ropes/Chains: N/A Replace Remarks: Owner wants to replace the existing glass with clear single pane glass cut to fit into existing wood frames. Windows tilt in from the top Weatherstripping: None		Remove paint Repair Paint and repair
Remove paint Replace Trim: Wood Remove paint Replace Trim: Hardware paint Replace Dimensions of window: 32" x 42" Hardware Description: Metal catch at top Remove paint Missing Replace Replace Ropes/Chains: N/A Replace Remarks: Owner wants to replace the existing glass with clear single pane glass cut to fit into existing wood frames. Windows tilt in from the top		
Repair Replace Trim: Wood Remove paint Replace Trim: Hood Remove paint Replace Dimensions of window: 32" x 42" Hardware Description: Metal catch at top Remove paint Metal catch at top Remove paint Missing Replace Ropes/Chains: N/A Replace Remarks: Owner wants to replace the existing glass with clear single pane glass cut to fit into existing wood frames. Windows tilt in from the top		
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32" x 42" Hardware Description: Metal catch at top Remove paint Missing Replace Ropes/Chains: N/A Replace Remarks: Owner wants to replace the existing glass with clear single pane glass cut to fit into existing wood frames. Windows tilt in from the top Weatherstripping: None		Repair Paint and repair
Remove paint Missing Replace Ropes/Chains: N/A Replace Remarks: Owner wants to replace the existing glass with clear single pane glass cut to fit into existing wood frames. Windows tilt in from the top	Dimensions of window:	-
Remarks: Owner wants to replace the existing glass with clear single pane glass cut to fit into existing wood frames. Windows tilt in from the top	32" x 42"	Hardware Description: Metal catch at top
Remarks: Owner wants to replace the existing glass with clear single pane glass cut to fit into existing wood frames. Windows tilt in from the top		
Remarks: Owner wants to replace the existing glass with clear single pane glass cut to fit into existing wood frames. Windows tilt in from the top		· Wissing
Remarks: Owner wants to replace the existing glass with clear single pane glass cut to fit into existing wood frames. Windows tilt in from the top		Ropes/Chains: N/A
Owner wants to replace the existing glass with clear single pane glass cut to fit into existing wood frames. Windows tilt in from the top		Replace
glass cut to fit into existing wood frames. Windows tilt in from the top	Remarks:	
	glass cut to fit into existing wood frames. Windows tilt in from the top	



Product Data

WeatherMaker® Single Packaged Rooftop

3 to 6 Nominal Tons





48/50FC**04, 05, 06, 07

48FC: Single-Package Gas Heating/Electric Cooling Rooftop Units 50FC: Electric Cooling Rooftop Units with Optional Electric Heat with Puron® Refrigerant (R-410A)

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